


LAYOUT PLAN OF BAY K
SCALE 1:200

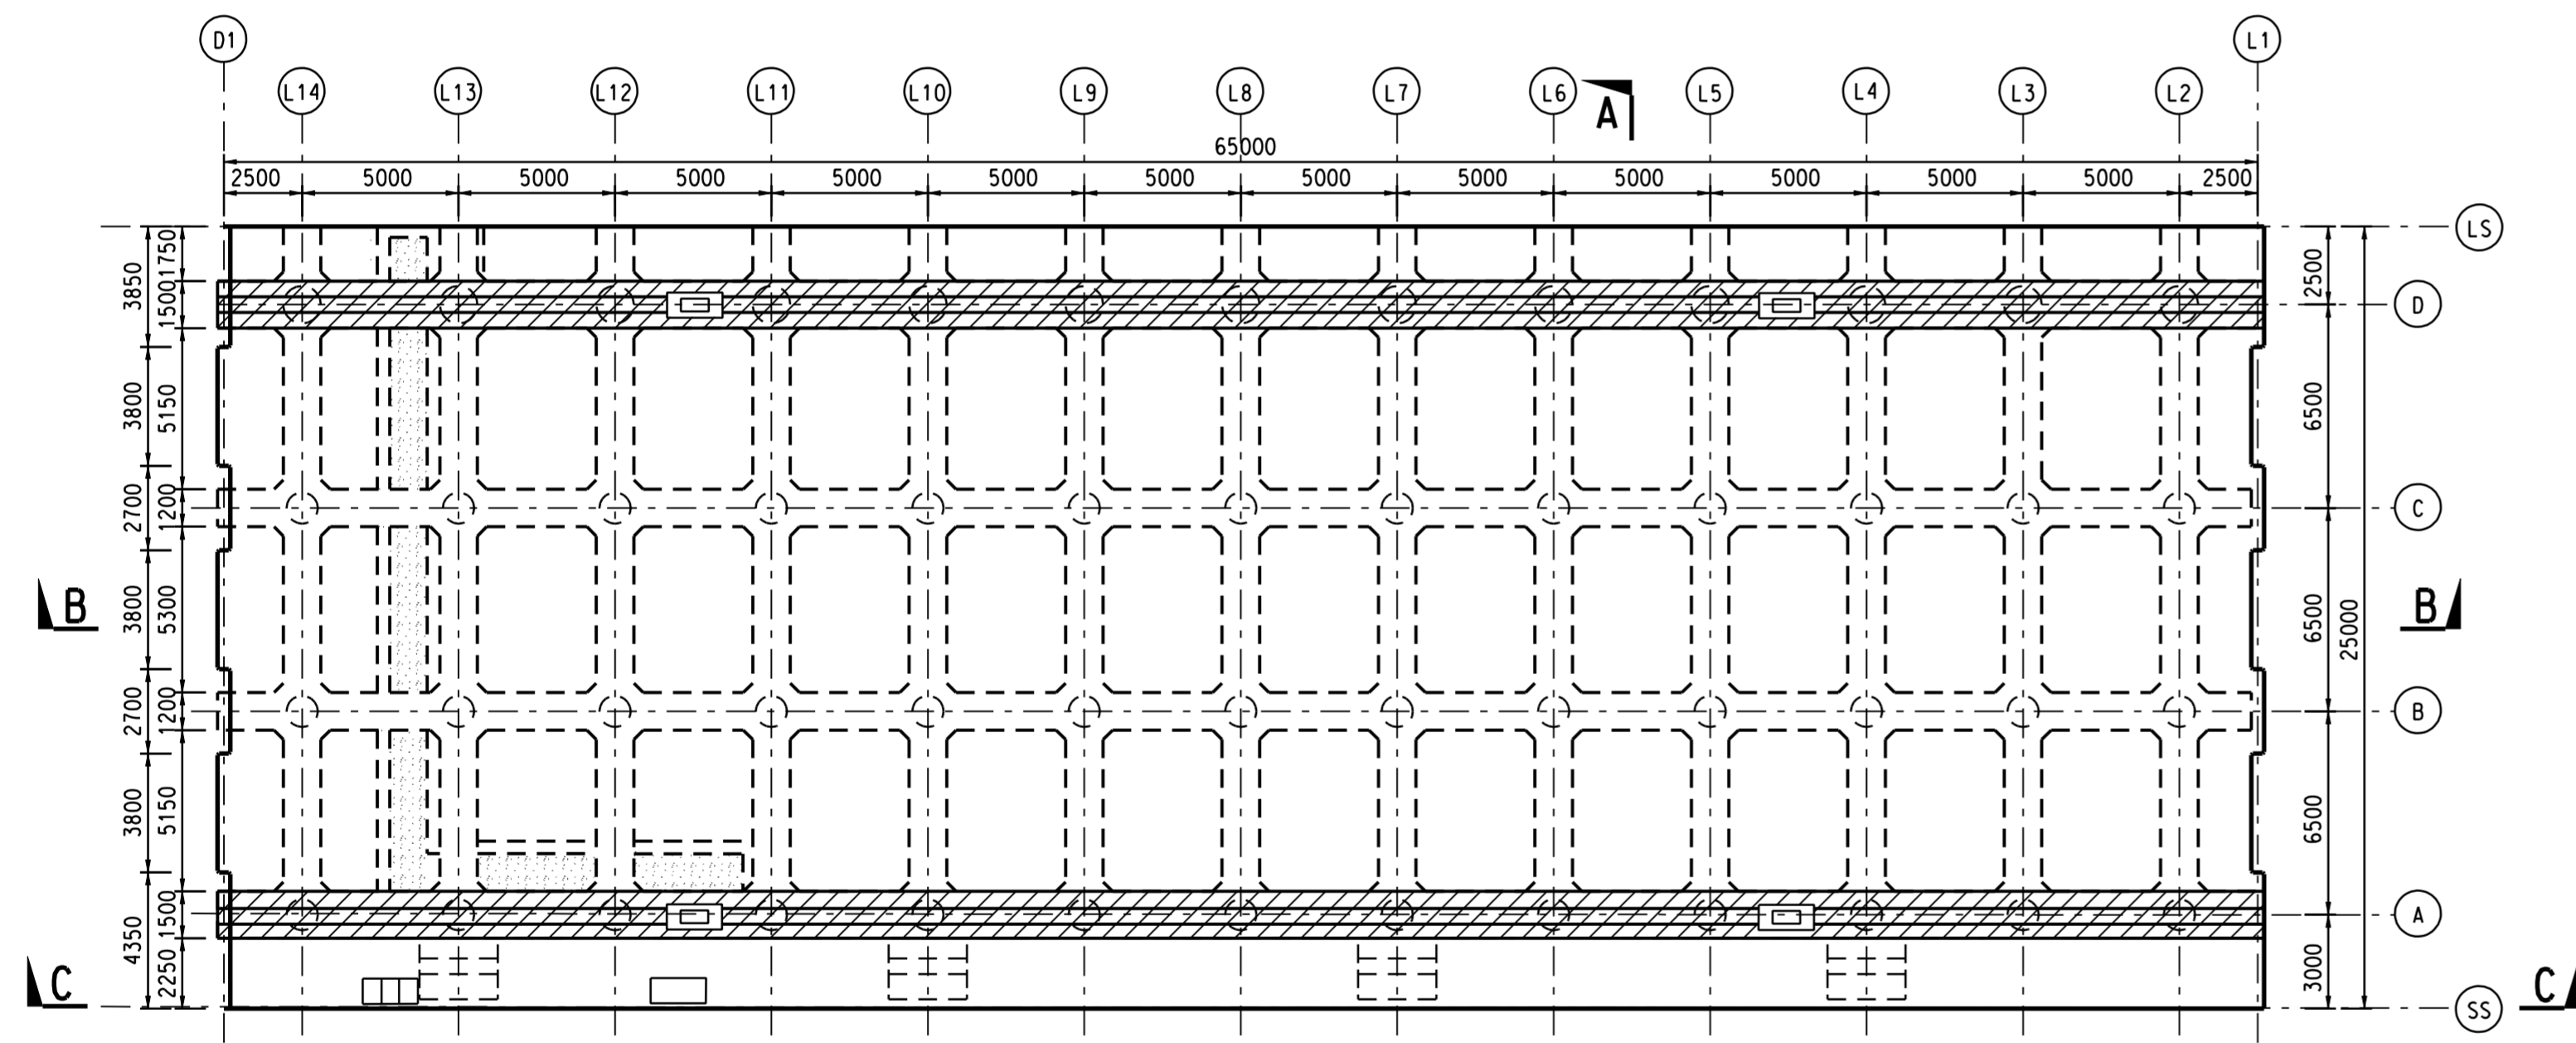

LAYOUT PLAN OF BAY L
SCALE 1:200

NOTES:

1. THIS DRAWING SHALL BE READ IN CONJUNCTION WITH DRG. NO. 421 TO 424 AND 426.
2. FOR GENERAL NOTES, REFER DRG. NO. 401.
3. FENDERS AND BOLLARDS ARE NOT SHOWN FOR CLARITY. FOR LOCATIONS REFER DRG. NO. 401.
4. FOR PILING DETAILS, REFER DRG. NO. 411 TO 414.
5. FOR DETAILS OF FENDER, BOLLARD AND ACCESS LADDER REFER DRG. NO. 431.
6. FOR MOVEMENT JOINT DETAILS, REFER DRG. NO. 432.
7. FOR TYPICAL UTILITY TROUGH ARRANGEMENT, REFER DRG. NO. 441 TO 443.
8. THE LOCATIONS OF TIE DOWN ANCHORS FOR PASSENGER GANGWAYS ARE BASED ON THE ASSUMED GANGWAY SIZE AND POSITION. ALTOGETHER 6 SETS OF TIE DOWN ANCHORS ARE PROPOSED.

LEGEND:

- ACCESS LADDER
- RAIL RESERVE
- TIE DOWN ANCHOR FOR PASSENGER GANGWAY
- POSSIBLE POWER FEEDER PIT FOR ON-SHORE POWER SUPPLY SYSTEM AT APPROX. 80m c/c SPACING
- WATER SUPPLY CONNECTION PIT AT APPROX. 100m c/c SPACING
- ELECTRICITY CONNECTION PIT AT APPROX. 80m c/c SPACING
- SHORE SEWAGE RECEPTION PIT AT APPROX. 100m c/c SPACING
- UTILITY TROUGH

REV.	DESCRIPTION	BY	CHKD.	DATE

Civil Engineering and Development Department
 土木工程發展處
 KOWLOON DEVELOPMENT OFFICE
 九龍發展處



KAI TAK DEVELOPMENT
 ENGINEERING STUDY CUM DESIGN AND
 CONSTRUCTION OF ADVANCE WORKS - INVESTIGATION,
 DESIGN AND CONSTRUCTION

SITE FORMATION CUM MARINE WORKS

EDGE STRUCTURES
**QUAY - BAYS K & L
 FRAMING PLAN**
 SHEET 5 OF 5

MAUNSELL | AECOM

Maunsell Consultants Asia Ltd.
 茂盛(亞洲)工程顧問有限公司

DRG.NO. 425
 圖紙編號

DESIGNED BY 設計	AGREEMENT NO. 合約編號	P. 01+ APPROVED 負責人
J.L.	CE35/2006 (CE)	

DRAWN BY 繪圖	STATUS 階段
J.J.	

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A1 AS SHOWN	MILLIMETRES	